

September 2, 2025

Mr. Corey Broersma Assistant Community Development Director Holland Charter Township 353 North 120<sup>th</sup> Ave. Holland, MI 49424

RE: JDS Contractor Facility: Special Land Use / Site Plan Submittal

12830 Quincy Street

Holland Charter Township, Ottawa County, Michigan

Dear Mr. Broersma:

Enclosed please find the following items that are being submitted for review and approval of the special land use for the project. Note that it is our understanding that the site plan approval will be by township staff:

- Eleven (11) Copies of the Site Plan Set
- Special Use Approval Application
- Site Plan Approval Application
- Site Plan Checklist
- Project Narrative
- Drainage Calculations
- Review Fee Checks (\$350.00 for the Special Land Use plus \$100.00 for the Site Plan Review fee(staff))

Please review this information and place the project on the October 7 Planning Commission agenda.

If you have any questions or need additional information, please contact me at (616) 292-5953 or via email at switte@nederveld.com.

Sincerely,

Steve Witte, P.E. Project Manager

Enclosures

 $K: \verb|\25201201| OUTGOING| SitePlanSubmittal| CoverLetter. CoreyB. doc$ 

# JDS Contractor Facility 12830 Quincy Street

#### Overview:

JDS, LLC, owns the vacant property located at 12830 Quincy Street. The property covers approximately 4.54 acres and is currently zoned I-2 General Industrial.

JDS is proposing to construct two new 23,360 sf +/- buildings that will be divided in to tenant space for contractors to lease. Therefore, the proposed use is considered to be a 'Contractor Facility', which requires Special Land Use approval. The building and site will be constructed in two phases, with the west building and the majority of the site work being constructed as Phase 1. The second, east building and the pavement within 20 ft +/- of the east building will be constructed as a Phase 2. Construction of Phase 1 will commence promptly pending approvals and permits. The Phase 2 building will be constructed based on demand for the tenant space.

The proposed Contractor Facility use fits in with the surrounding area. Note that Tractor Supply Company and their outdoor sales/display area is located to the immediate north of the site. Brenner Oil Company has their truck parking located to the immediate west of the site. And Chips Ground Cover, Grand Rapids Gravel, and similar uses are located in close proximity to the site.

The site will be accessed via a proposed new driveway off Quincy Street, with the new driveway lined up opposite the existing driveway to Tractor Supply Company. The driveway location and design is subject to the review, approval, and permitting through the Ottawa County Road Commission.

Sufficient parking spaces and truck turning areas are provided between the two proposed buildings and at the south end of the site.

Both buildings will be serviced by public sanitary sewer and public watermain. Both of these utilities are available in Quincy Street. The storm water runoff from the property will be collected and detained on-site per Ottawa County Water Resources Commission (OCWRC) standards. The drainage design is subject to the review and approval of OCWRC>

The buildings will primarily be metal sided buildings, with doors and building enhancements provided at each tenant space entrance. Each tenant space will be provided with an OH door, a main man door entrance, and a secondary/emergency door to the rear of the units. It is anticipated that the buildings will be approximately 24 ft tall.


Landscaping will be provided on the property as required by the township zoning ordinance.

### Experience . . . the Difference **BENCHMARKS** BENCHMARK #500 ELEV. = 626.92 (NAVD88) Top of flange bolt on hydrant (under "E" in "EJIW") located 33'± N. of C/L Quincy St. & 12.5' ± W. of property line. BENCHMARK #586 ELEV. = 624.88 (NAVD88) Top of flange bolt on hydrant (under "W" in "EJIW") located 33'± N. of C/L Quincy St. & 20' ± W. of property line. STRUCTURE INFORMATION SAN MH #596 SAN MH (FROM PREVIOUS) Rim Elev. = 625.90 12" INV. E. 613.99 **LOCATION MAP** 12" INV. E. 613.12 12" INV. W. 613.99 12" INV. W. 613.12 BENCHMARK #586 EX. DRIVEWAY ELEV. = 624.88 **QUINCY STREET** M = S89°15'22"E 383.74' 150.00' **REMOVAL / DEMOLITION NOTES** 1) THE CONTRACTOR SHALL NOTIFY THE UTILITY COMPANIES AT LEAST THREE WEEKS PRIOR TO THE BEGINNING OF CONSTRUCTION OPERATIONS. THERE ARE EXISTING UNDERGROUND UTILITIES WHICH CROSS THE PROPOSED REPLACEMENT WORK AREAS. ALTHOUGH THEIR EXACT LOCATION CANNOT BE DETERMINED, IT IS KNOWN THESE UTILITIES ARE LOCATED WHERE DIGGING IS REQUIRED. THE CONTRACTOR SHALL CONDUCT THE REQUIRED EXCAVATION IN THESE AREAS WITH EXTREME CAUTION. 2) ALL EXISTING UTILITY INFORMATION SHOWN IS TAKEN FROM EXISTING RECORDS, AND FIELD VERIFIED WHERE ACCESSIBLE ONLY. INFORMATION OBTAINED FROM EXISTING RECORDS MAY NOT BE COMPLETE OR ACCURATE. THE LOCATION OF ALL EXISTING UTILITIES SHOWN ON THIS PLAN HAVE BEEN DETERMINED FROM THE BEST INFORMATION AVAILABLE AND ARE GIVEN FOR THE CONVENIENCE OF THE CONTRACTOR. THE ENGINEER ASSUMES NO RESPONSIBILITY FOR THEIR ACCURACY. THE CONTRACTOR SHALL FIELD VERIFY FOR ACCURACY, LOCATION AND CONDITION. 3) BEFORE ANY WORK IS STARTED ON THE PROJECT AND AGAIN BEFORE FINAL ACCEPTANCE BY THE CITY AND BY THE OWNER, REPRESENTATIVES OF THE CITY, THE OWNER AND THE CONTRACTOR SHALL MAKE AN INSPECTION OF THE EXISTING SEWERS WITHIN THE WORK LIMITS WHICH ARE TO REMAIN IN SERVICE AND WHICH MAY BE AFFECTED BY THE WORK. THE CONDITION OF THE EXISTING UTILITIES AND THEIR APPURTENANCES SHALL BE DETERMINED FROM FIELD OBSERVATIONS AND EXISTING VIDEO TAPES. RECORDS OF THE INSPECTIONS SHALL BE KEPT IN WRITING BY THE CONTRACTOR. 4) THE CONTRACTOR IS RESPONSIBLE FOR OBTAINING ALL PERMITS REQUIRED FOR DEMOLITION WORK. 5) ALL EXISTING UTILITIES, SEWERS AND WATER LINES ARE TO REMAIN UNDISTURBED UNLESS OTHERWISE NOTED ON THE WNER: BENSINK, LLC PLANS. THE CONTRACTOR SHALL CONTACT AND COORDINATE WITH ALL APPLICABLE UTILITY COMPANIES, MUNICIPALITIES AND AGENCIES BEFORE COMMENCING ANY WORK. 6) THE CONTRACTOR SHALL COORDINATE WITH ALL UTILITY COMPANIES REGARDING REMOVAL OF EXISTING POLES, OVERHEAD WIRES, UNDERGROUND UTILITIES, GUY WIRES, GAS LINES, ETC. ALL ADJUSTMENT OR RECONSTRUCTION WORK, EXCEPT FOR THOSE STRUCTURES OTHERWISE NOTED ON THE PLANS, SHALL BE PERFORMED BY THE CONTRACTOR. EXISTING APPURTENANCES SUCH AS UTILITY POLES AND VALVES BOX SHALL NOT BE DISTURBED BY THE CONTRACTOR DURING CONSTRUCTION. 7) THE CONTRACTOR SHALL MAINTAIN EXISTING UTILITY SERVICE TO ALL ADJOINING PROPERTIES. 8) ALL DEBRIS SHALL BE REMOVED FROM THE SITE, AND NO STOCKPILING ON SITE SHALL BE ALLOWED UNLESS APPROVED BY THE OWNER OR THEIR REPRESENTATIVES. 9) THE CONTRACTOR SHALL LIMIT SAWCUT AND PAVEMENT REMOVAL TO ONLY THOSE AREAS WHERE REQUIRED OR AS EXISTING JOINTS. IF ANY DAMAGE IS INCURRED TO ANY OF THE SURROUNDING PAVEMENT, THE CONTRACTOR SHALL BE RESPONSIBLE FOR ITS REMOVAL AND REPAIR AT NO ADDITIONAL COST TO ANYONE ELSE, INCLUDING THE CITY OR OWNER. 10) ASPHALT AREAS SHOWN TO BE SAWCUT AND REMOVED FULL DEPTH ARE ACTUAL FACE OF PROPOSED CURBS. IT WILL BE NECESSARY TO MAKE OFF-SET SAWCUTS TO PROVIDE CLEARANCE FOR PROPOSED CURBS: THE CONTRACTOR SHALL DETERMINE THE AMOUNT OF OFF-SET NECESSARY TO CONSTRUCT THE PROPOSED CURBS. ADDITIONAL CUTS MAY BE DESIRED TO FACILITATE THE REMOVAL OF THE EXISTING PAVEMENT, BUT THERE WILL BE NO EXTRA PAYMENT FOR ADDITIONAL CUTS. PAVEMENT SHALL BE REMOVED WITHOUT DAMAGING OR UNDERMINING THE REMAINING PAVEMENT. IF ADJACENT PAVEMENT IS DAMAGED, THE CONTRACTOR SHALL MAKE ADDITIONAL FULL DEPTH SAWCUTS AND REMOVE THE 11) ALL PAVEMENT REMOVAL AREAS SHALL BE FULL PAVEMENT CROSS-SECTION REMOVAL DOWN TO NATIVE SOIL LAYER IN ACCORDANCE WITH THE GEOTECHNICAL REPORT. 12) ALL TREES AND VEGETATION WITHIN THE GRADING LIMITS SHALL BE REMOVED UNLESS OTHERWISE NOTED. **REMOVAL / DEMOLITION NOTES** EXISTING UTILITY POLE SHALL BE RELOCATED AS NECESSARY FOR NEW DRIVEWAY APPROACH. CONTRACTOR SHALL COORDINATE WORK WITH UTILITY COMPANY, OCRC, AND THE PROPERTY OWNER. SAWCUT, REMOVE, AND REPLACE EX. QUINCY STREET PAVEMENT AND CURB AS NECESSARY FOR NEW WATER SERVICES. REPAID/DEDI ACE WITH LIVE MATERIAL ACCIDENTED TO ACCIDENT STREET PAVEMENT AND CURB AS NECESSARY FOR NEW WATER SERVICES. REPAIR/REPLACE WITH LIKE MATERIALS AS DIRECTED BY OCRC. SAWCUT, REMOVE, AND REPLACE EDGE OF EX ASPHALT AS NECESSARY TO PROVIDE SMOOTH TRANSITION BETWEEN EXISTING AND PROPOSED PAVEMENT. REMOVE EXISTING TREES AND VEGETATION AS NECESSARY FOR CONSTRUCTION (TYP).

PP # 70-16-08-200-023 OWNER: IMMO US CORP

ADDRESS: 3900 JOHN F DONNELLY DR ZONED: I-2 GENERAL INDUSTRIAL DISTRICT

QUINCY STREET SITE REFLECTIONS DR. GREENLY STREET

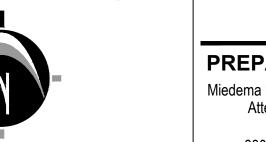

SCALE: 1" = 30'

### **LEGEND**

Control Point/ Benchmark Electric Riser Miss Dig Flag - Sanitary Sanitary Manhole Utility Pole

800.222.1868 GRAND RAPIDS 217 Grandville Ave., Suite 302 Grand Rapids, MI 49503 Phone: 616.575.5190 **ANN ARBOR** 3037 Miller Rd. Ann Arbor, MI 48103 Phone: 734.929.6963 HOLLAND 730 Chicago Dr. Holland, MI 49423 Phone: 616.393.0449

PREPARED FOR: Miedema Metal Building Systems, Inc. Attention: Alex Miedema

> 3309 Hudson Trails Drive Hudsonville, MI 49426 Phone: 616.896.1700

### **REVISIONS:**

Title: Preliminary Plan Drawn: SW Checked: SW Date: 09/05/25 Title: Site Plan Drawn: SW Checked: SW Date: 09/08/25

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SEAL:

PROJECT NO:

25201201

SHEET NO:

PP # 70-16-08-200-025 OWNER: BENSINK, LLC ADDRESS: 12839 CORPORATE CIRCLE PL ZONED: I-2 GENERAL INDUSTRIAL DISTRICT

N89°15'22"W 518.75'

1) Flood Zone Classification: An examination of the National Flood Insurance Program's Flood Insurance Rate Map for Community Number 26139C, Panel Number 0305E, with an Effective Date of 12/16/2011, shows this parcel to be located in Zone "X" (subject to map scale uncertainty).

TAX DESCRIPTION: Part of the Northeast 1/4 of Section 8, Town 5 North, Range 15 West, Holland Township, Ottawa County, Michigan, described as: Commencing North 89 degrees 15 minutes 22 seconds West 321.56 feet from the Northeast Section corner; thence South 15 degrees 57 minutes 22 seconds East 469.82 feet along the Westerly right-of-way line of 128th Ave, North 89 degrees 15 minutes 22 seconds West 668.75 feet, North 00 degrees 44 minutes 38 seconds East 450 feet, thence South 89 degrees 15 minutes 22 seconds East 533.74 feet to

**LEGAL DESCRIPTION** 

the Place of Beginning, except the Westerly 150 feet.

**SURVEYOR'S NOTES** 

2) Source information from plans and markings has been combined with observed evidence of utilities to develop a view of the underground utilities. However, lacking excavation, the exact location of underground features cannot be accurately, completely, and reliably depicted. In addition, in some jurisdictions, 811 or other similar utility locate requests from surveyors may be ignored or result in an incomplete response. Where additional or more detailed information is required, the client is advised that excavation may be necessary.

3) NOTE TO CONTRACTORS: 3 (THREE) WORKING DAYS BEFORE YOU DIG, CALL MISS DIG AT TOLL FREE

1-800-482-7171 FOR UTILITY LOCATIONS ON THE GROUND. — Land Planning — Landscape Architecture — Civil Engineering — Land Surveying — Reality Capture — Forensic Services —

UTILITY LOCATIONS ARE DERIVED FROM ACTUAL MEASUREMENTS OR AVAILABLE RECORDS. THEY SHOULD NOT BE INTERPRETED TO BE EXACT LOCATIONS NOR SHOULD IT BE ASSUMED THAT THEY ARE THE ONLY UTILITIES IN THIS AREA.

Inv. Elev. = 621.54

NOTE: EXISTING UTILITIES AND SERVICE LINES IDENTIFIED AS "(PLAN)" WERE OBTAINED FROM AVAILABLE AS-BUILT RECORD DRAWINGS. THE


CONTRACTOR SHALL VERIFY THE LOCATION, DEPTH AND STATUS OF ALL UTILITIES AND SERVICE LINES PRIOR TO NEW CONNECTIONS.

Know what's **below**.

——Land Planning — Landscape Architecture — Civil Engineering — Land Surveying — Reality Capture — Forensic Services ———

ONLY UTILITIES IN THIS AREA.

EXISTING UTILITIES AND SERVICE LINES IDENTIFIED AS "(PLAN)" WERE CONTRACTOR SHALL VERIFY THE LOCATION, DEPTH AND STATUS OF ALL

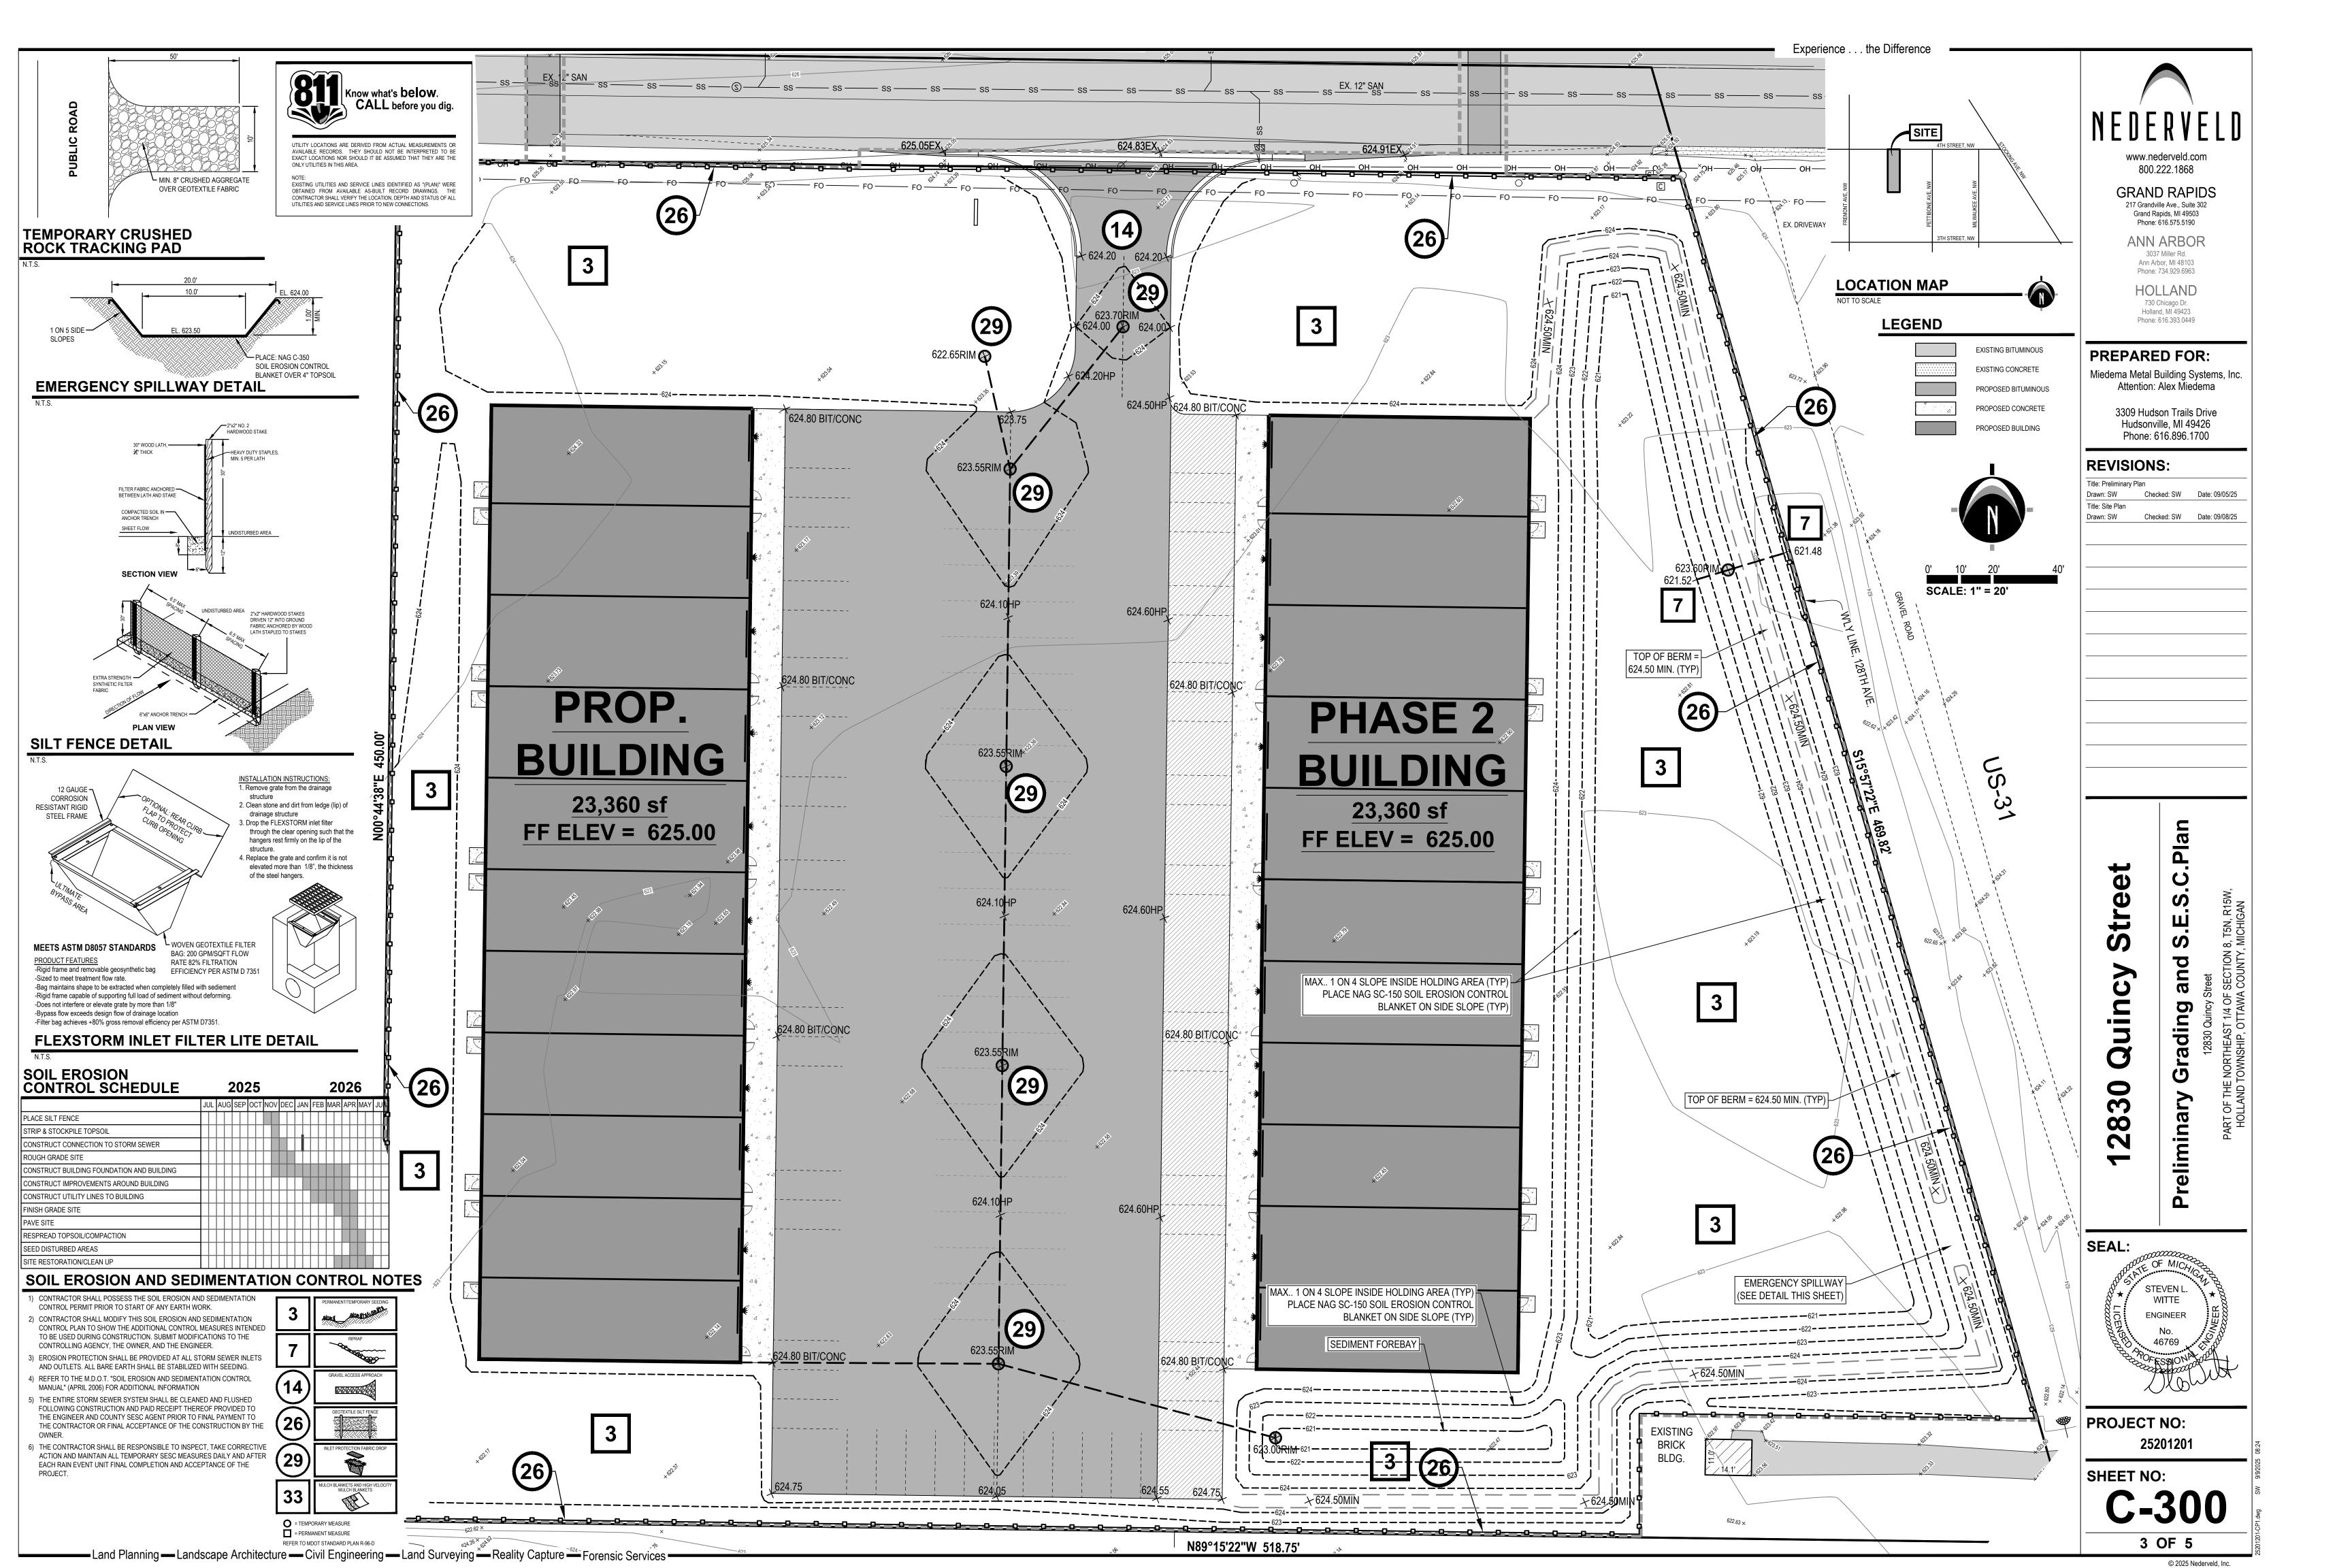

Land Planning — Landscape Architecture — Civil Engineering — Land Surveying — Reality Capture — Forensic Services




UTILITY LOCATIONS ARE DERIVED FROM ACTUAL MEASUREMENTS OF EXACT LOCATIONS NOR SHOULD IT BE ASSUMED THAT THEY ARE THE

EX. DRIVEWAY

NOTE: EXISTING UTILITIES AND SERVICE LINES IDENTIFIED AS "(PLAN)" WERE OBTAINED FROM AVAILABLE AS-BUILT RECORD DRAWINGS. TH CONTRACTOR SHALL VERIFY THE LOCATION, DEPTH AND STATUS OF ALL UTILITIES AND SERVICE LINES PRIOR TO NEW CONNECTIONS.

## **LEGEND**

**EXISTING BITUMINOUS** EXISTING CONCRETE PROPOSED BITUMINOUS (STANDARD DUTY) PROPOSED GRAVEL

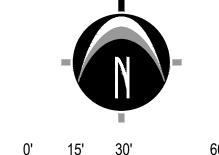


FORM 2" SAUCER — - 3" SHREDDED HARDWOOD MULCH (CONTINUOUS) TOPSOIL OR GOOD NATIVE SOIL THAT HAS -BEEN AMENDED FOR PLANTING (FREE FROM -EXCAVATE PLANT WELL 1.5 TIMES THE CLODS, ROCKS, STICKS, ETC.). PLACE SOIL IN SIZE OF THE CONTAINER 6 INCH LIFTS; LIGHTLY TAMP AND WATER AFTER EACH LIFT TO REMOVE AIR POCKETS.

> \_\_\_\_\_\_ \_\_\_\_\_\_

**EXISTING** BRICK BLDG.

SHOWN ON THIS PLAN, SUBJECT TO TOWNSHIP STAFF

ORNAMENTAL GRASS PLANTING DETAIL

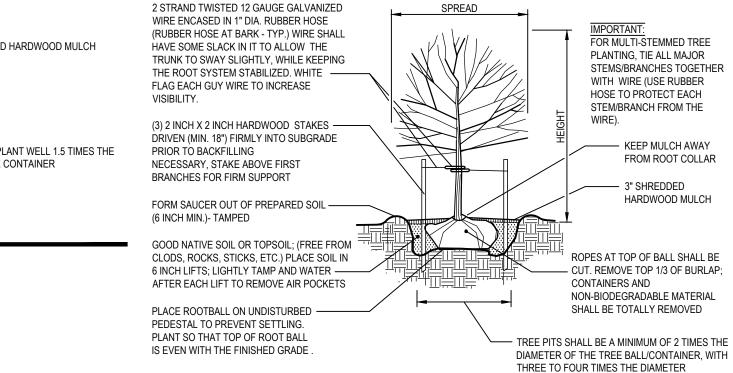

**TYPICAL TREE PLANTING DETAIL** 

TYPE D: ADJACENT I-2, 1 CANOPY OR EVERGREEN TREE PER 60 LINEAR FEET ALONG THE PROPERTY LINE

LANDSCAPE CALCULATIONS

FRONT YARD LANDSCAPE: SEC. 11.6

1 TREE & 3 SHRUBS PER 40 LF FRONTAGE

QUINCY ST FRONTAGE: 383.74 LF / 40 = 9.59

REQUIRED: 10 TREES & 29 SHRUBS

SOUTH I-2 BUFFER: TYPE D: 518.75 LF

PARKING LOT CANOPY TREES: SEC. 11.9

REQUIRED: 3 TREES & 316 SQFT OF LANDSCAPE

1 CANOPY TREE & 100 SQFT LANDSCAPE PER 12 SPACES OR FRACTION THEREOF.

EAST I-2 BUFFER: TYPE D: 450 LF

PARKING TOTAL: 38 SPACES

REQUIRED: 9 TREES

REQUIRED: 8 TREES

RECOMMENDED.

PROPOSED: 10 TREES & 29 SHRUBS

PROPOSED: 3 TREES & 316 SQFT OF LANDSCAPE

PROPOSED: 9 TREES

PROPOSED: 8 TREES



### **PLANTING NOTES:**

1) ALL PLANT MATERIAL SHALL BE LOCALLY NURSERY GROWN NO.1 GRADE AND INSTALLED ACCORDING TO ACCEPTED OR AFTER IT IS INSTALLED.

4) MAINTENANCE OF LANDSCAPING ITEMS. TREES, AND PLANTS SHALL BE PERFORMED BY THE PROPERTY OWNER OR A

7) FINELY SHREDDED HARDWOOD BARK MULCH, NATURAL COLOR (NON-COLORED), IS REQUIRED FOR ALL PLANTINGS AND PLANTING BEDS. MULCH PER PLANTING DETAILS. MULCH IN PLANT BEDS SHALL BE 3" THICK AT TIME OF INSPECTION AND AFTER COMPACTED BY RAIN OR IRRIGATION. ALL PLANTING BEDS SHALL BE EDGED WITH 6" X 12 GAUGE STEEL LANDSCAPE

8) LANDSCAPE CONTRACTOR SHALL BE RESPONSIBLE FOR THE VERIFICATION OF ALL UNDERGROUND AND OVERHEAD

#### **TOPSOIL AND TURF NOTES:**

- CONTROL REGULATIONS SHALL BE STRICTLY FOLLOWED AND COMPLIED WITH.
- OTHERWISE. DO NOT PLANT UNTIL ACCEPTANCE OF FINISH GRADE.
- 5) TURF SHALL BE INSTALLED ON A MIN. OF 3"-4" OF LIGHTLY COMPACTED APPROVED TOPSOIL. TOPSOIL SHALL BE FERTILE, SCREENED, FRIABLE TOPSOIL FREE OF STONES 1/2" IN DIA. AND LARGER, ROOTS, STICKS, OR OTHER EXTRANEOUS MATERIAL INCLUDING NOXIOUS PLANTS. PH BETWEEN 6.0 AND 6.5, SALTS 500 PARTS PPM, ORGANIC CONTENT 3% MIN. DO NOT INSTALL TOPSOIL UNTIL APPROVED BY OWNER/C.M.. TOPSOIL SHALL BE FINE GRADED TO A SMOOTH FINISH, FREE OF LUMPS AND DEPRESSIONS.
- 6) ALL LANDSCAPE ISLANDS WITHIN PARKING LOTS SHALL BE BACK FILLED WITH TOPSOIL TO A DEPTH OF 18" MIN.

#### **IRRIGATION NOTES:**

1) ALL PLANTING AREAS, LAWN AREAS AND LANDSCAPE ISLANDS SHOWN ARE TO HAVE A COMPLETE IRRIGATION SYSTEM. THE G.C. SHALL BE RESPONSIBLE FOR RETAINING A QUALIFIED FIRM FOR THE DESIGN OF THE IRRIGATION SYSTEM. THE DESIGN

#### LANDSCAPE NOTES

PLANTING PROCEDURES. ALL PLANT MATERIALS SHALL MEET CURRENT AMERICAN ASSOCIATION OF NURSERYMEN STANDARDS. DO NOT PLANT MATERIALS UNTIL DIRECTED BY OWNER, LANDSCAPE ARCHITECT, AND/OR CONSTRUCTION MANAGER. THE LANDSCAPE ARCHITECT RESERVES THE RIGHT TO REJECT ANY PLANT MATERIAL, FOR ANY REASON BEFORE

2) SIZES SPECIFIED ARE MINIMUM SIZES TO WHICH THE PLANTS ARE TO BE INSTALLED. 3) ANY PLANT SUBSTITUTIONS SHALL BE APPROVED BY THE LANDSCAPE ARCHITECT.

- QUALIFIED PROFESSIONAL. ALL LANDSCAPING SHALL BE INSTALLED AND MAINTAINED IN ACCORDANCE WITH APPLICABLE MUNICIPAL STANDARDS AND IN ACCORDANCE WITH CURRENT INDUSTRY STANDARDS IN A NEAT, HEALTHY AND WEED FREE CONDITION. ANY DEAD, DISEASED OR DAMAGED PLANT MATERIALS ARE TO BE REPLACED IMMEDIATELY AFTER NOTIFIED TO
- SHRUBS AT THE SAME GRADE LEVEL AT WHICH THEY WERE GROWN AT THE NURSERY. IF HEAVY CLAY SOILS ARE EVIDENT, PLANT TREES AND SHRUBS HIGHER, APRROX. 1/4 OF THE ROOT BALL ABOVE GRADE, AND BACKFILL TO TOP OF ROOT BALL.
- 6) REMOVE ALL TWINE, WIRE, NURSERY TREE GUARDS, TAGS AND INORGANIC MATERIAL FROM ROOT BALLS. REMOVE THE TOP 1/3 OF BURLAP FROM EARTH BALLS AND REMOVE BURLAP FROM AROUND TRUNK.
- UTILITIES. IF A CONFLICT WITH UTILITIES EXIST, NOTIFY OWNER/CONSTRUCTION MANAGER PRIOR TO PLANTING.
- 9) PLANT MATERIAL SHALL BE GUARANTEED FOR ONE YEAR AFTER PLANTING AND ACCEPTANCE.
- I) WHEREVER GROUND IN ITS NATURAL STATE HAS BEEN DISTURBED, APPROVED LANDSCAPING OR GRASS SHALL BE FULLY INSTALLED, AND ESTABLISHED WITHIN A REASONABLE PERIOD OF TIME, BUT NO LONGER THAN ONE GROWING SEASON (UNLESS OTHERWISE NOTED AND APPROVED).
- 2) DURING EXCAVATION, GRADING, AND INSTALLATION OF REQUIRED LANDSCAPING, ALL SOIL EROSION AND SEDIMENTATION
- 3) ALL LAWN AREAS SHALL RECEIVE SOD OR HYDROSEED. TURF SHALL BE INSTALLED ON TOPSOIL UNLESS APPROVED
- 4) SOD SHALL BE GROWN ON TOPSOIL UNLESS APPROVED OTHERWISE. SOD SHALL BE 2 YEARS OLD AND STRONGLY ROOTED. RUNNING BOND PATTERN. SOD SHALL BE WATERED IMMEDIATELY TO AVOID DRYING OUT. DO NOT INSTALL SOD UNTIL ACCEPTANCE OF FINISH GRADE AND IRRIGATION SYSTEM IS OPERATING PROPERLY UNLESS DIRECTED IN WRITING TO DO OTHERWISE. FINISH ROLL SOD WITH A WATER FILLED LAWN ROLLER, ROLL PERPENDICULAR TO LENGTH OF SOD.

MUST SHOW HOW THE SYSTEM TIES INTO THE BUILDING AND MUST SHOW ALL OF THE NECESSARY EQUIPMENT FOR A COMPLETE SYSTEM. THE G.C. SHALL SUBMIT THE IRRIGATION SYSTEM DESIGN TO THE ARCHITECT/OWNER FOR APPROVAL PRIOR TO COMMENCEMENT OF WORK.

## LANDSCAPE SCHEDULE

TREES					
	Pg	Picea glauca 'Densata'	Black Hills Spruce	6' min.	11
•	Pc	Pinus cembra	Swiss Stone Pine	6' min.	7
+	Cg	Crataegus crus-galli	Thornless Hawthorn	2" cal.	2
•	Lt	Liriodendron tulipiferia	Tulip Poplar Tree	2.5" cal.	6
	Ns	Nyssa sylvatica	Black Gum	2.5" cal.	4
SHRUBS					
	Jc	Juniperus communis var. depressa	Low-Growing Juniper	24" min.	15
£ + }	Vd	Viburnum dentatum	Arrowwood Viburnum	24" min.	14

**BOTANICAL NAME** 



**GRAND RAPIDS** 217 Grandville Ave., Suite 302

**ANN ARBOR** 3037 Miller Rd. Ann Arbor, MI 48103

Grand Rapids, MI 49503

Phone: 616.575.5190

HOLLAND 730 Chicago Dr. Holland, MI 49423

Phone: 616.393.0449

Phone: 734.929.6963

PREPARED FOR:

Miedema Metal Building Systems, Inc. Attention: Alex Miedema

> 3309 Hudson Trails Drive Hudsonville, MI 49426 Phone: 616.896.1700

### **REVISIONS:**

Drawn: SW Checked: SW Date: 09/05/25 Title: Site Plan Checked: SW Date: 09/08/25

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COMMON NAME SIZE QTY

andscape



**PROJECT NO:** 25201201

SHEET NO:

— Land Planning — Landscape Architecture — Civil Engineering — Land Surveying — Reality Capture — Forensic Services -

PROPOSED CONCRETE (STANDARD DUTY)

TYPICAL SHRUB / PERENNIAL /

M = S89°15'22"E 383.74' EX. DRIVEWAY

\_\_\_\_\_\_ 

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**QUINCY STREET** 

PROP. PHASE 2

> 23,360 sf EXISTING TREES/VEGETATION ARE PRESERVED

ALONG THE PERIMETER OF THE SITE, THE PRESERVED REES CAN POTENTIALLY BE USED FOR THE REQUIRED BUFFER INSTEAD OF THE PROPOSED LANDSCAPING SHOWN ON THIS PLAN, SUBJECT TO TOWNSHIP STAFF APPROVAL (TYP)

BUILDING

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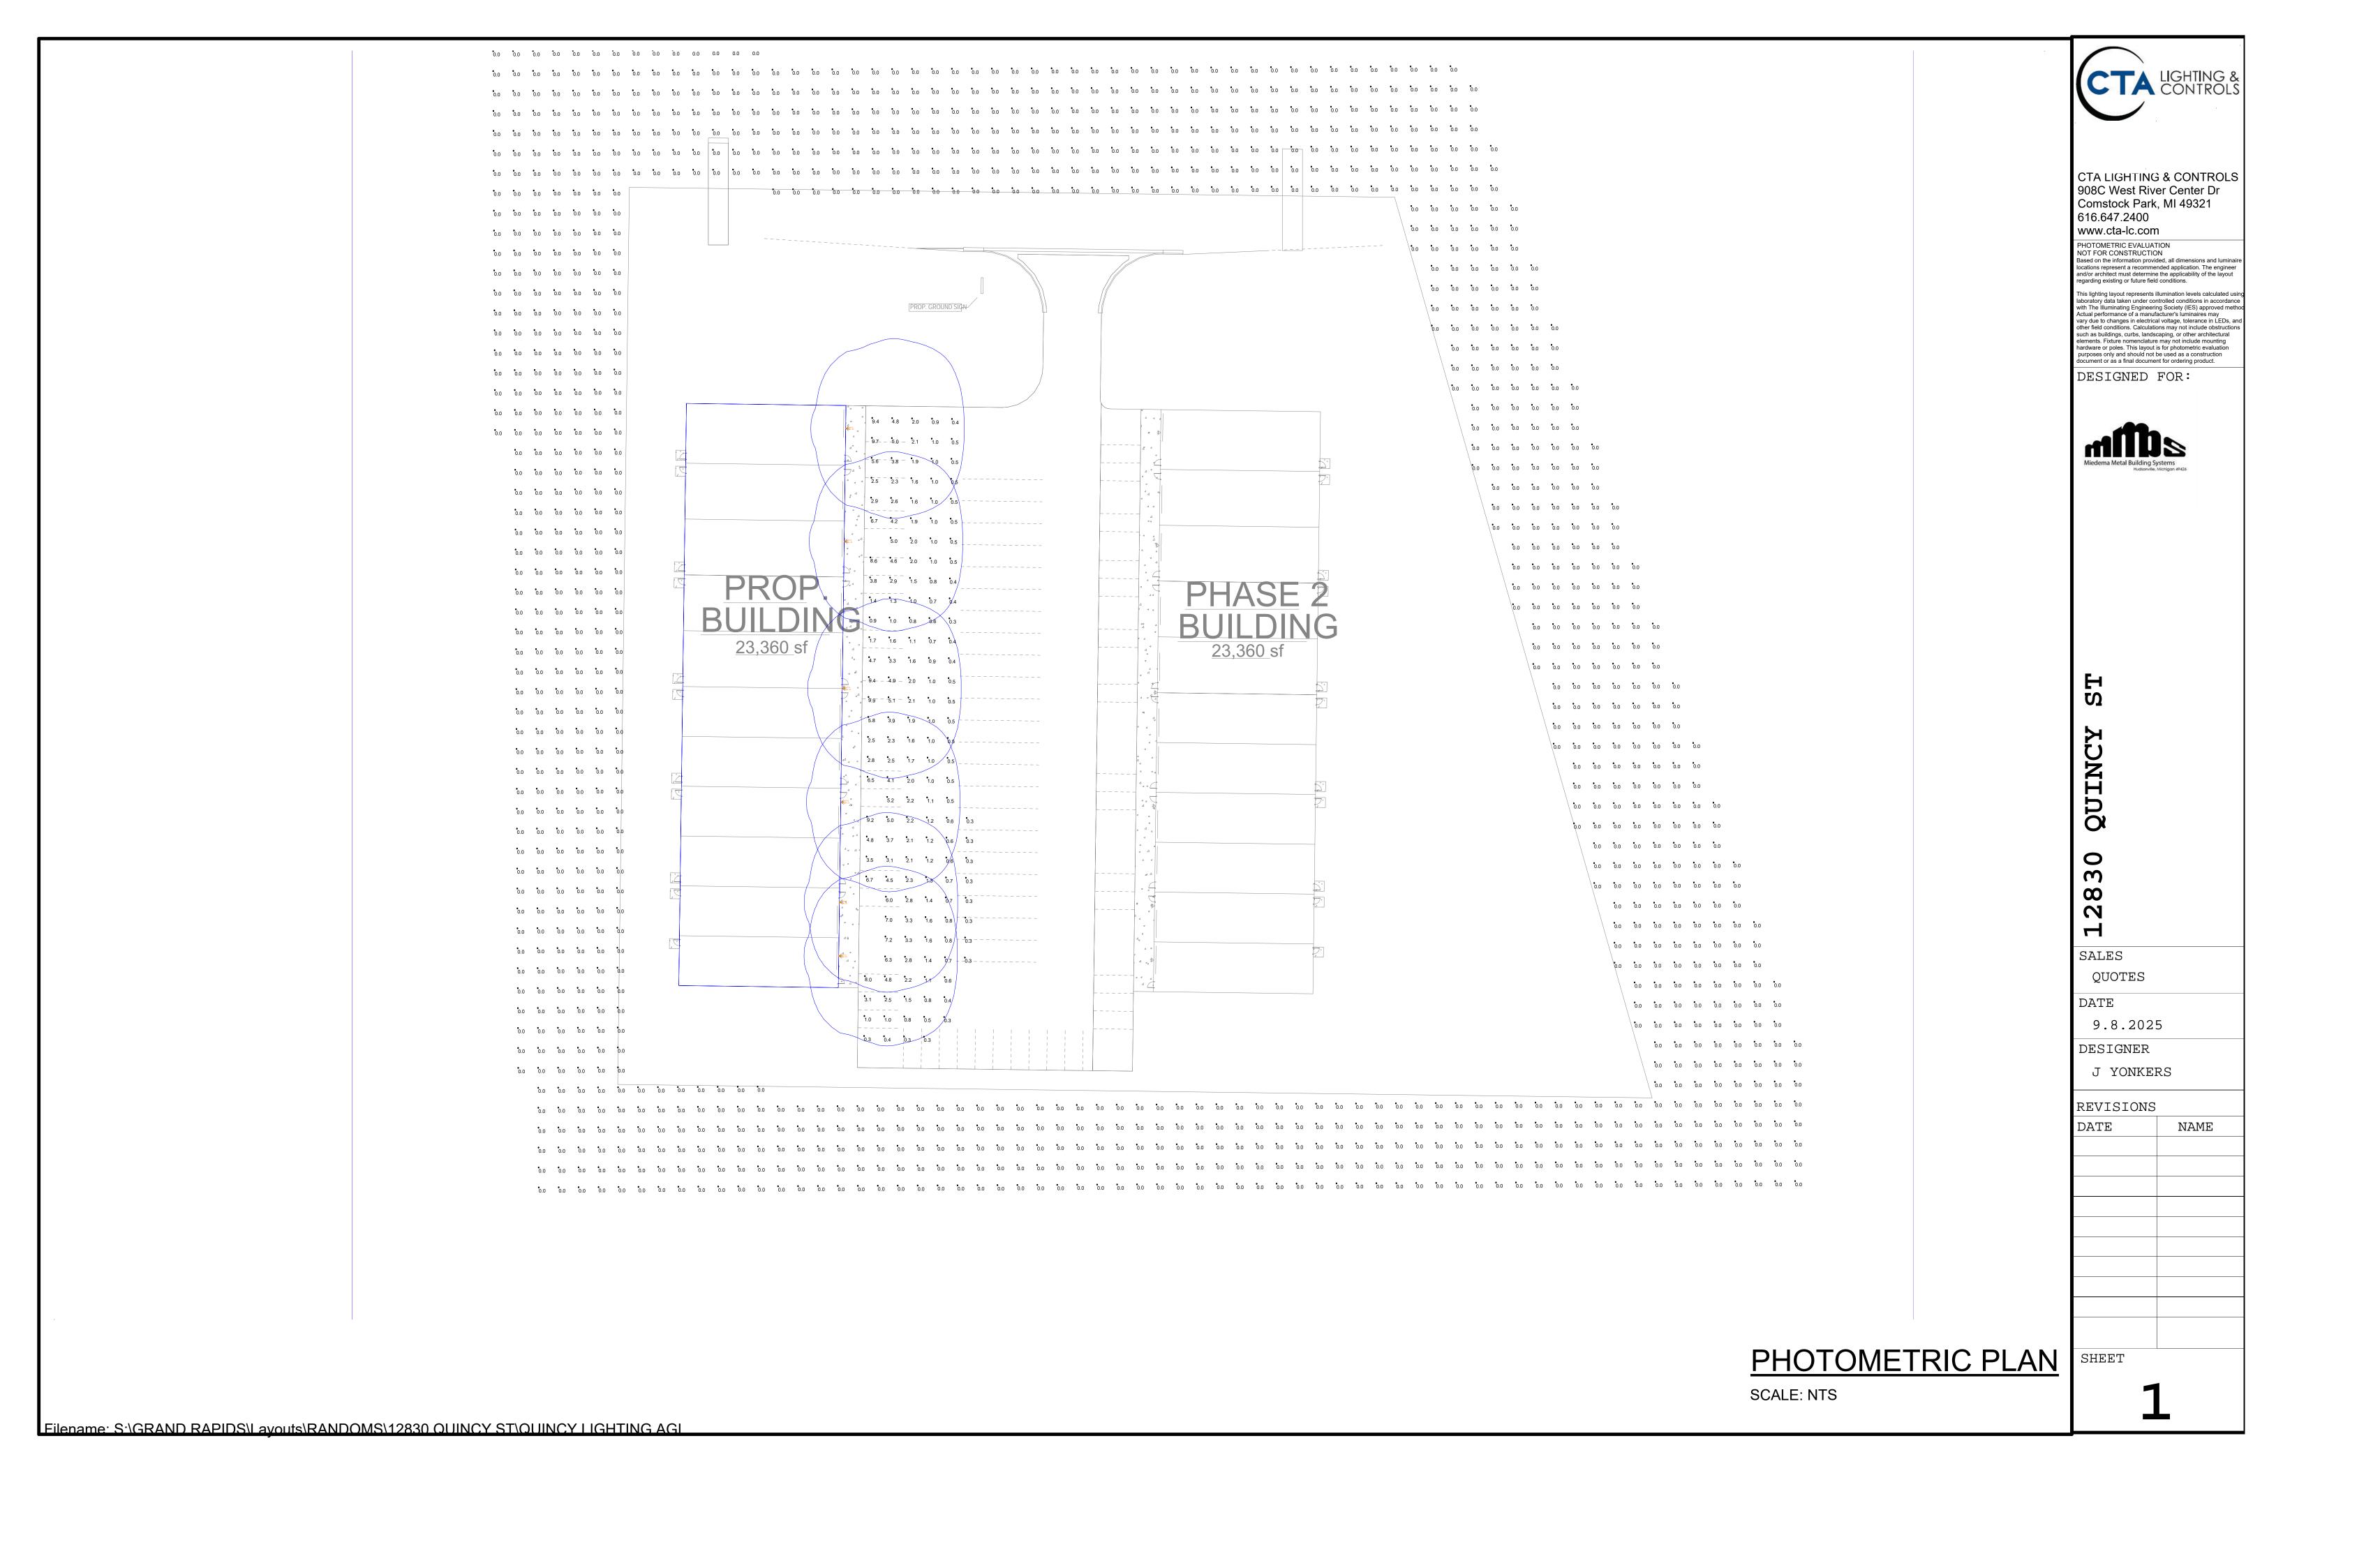
IF EXISTING TREES/VEGETATION ARE PRESERVED ALONG THE PERIMETER OF THE SITE, THE PRESERVED TREES CAN POTENTIALLY BE USED FOR THE REQUIRED BUFFER INSTEAD OF THE PROPOSED LANDSCAPING

APPROVAL (TYP)

N89°15'22"W 518.75'

**BUILDING** 


23,360 sf




Luminaire Schedule										
Scenario: GEN										
SYMBOL	QTY	LABEL	ARRANGMENT	LLF	[MANUFAC]	DESCRIPTION	MNT HEIGHT	MNT TYPE	TLT WATTS	LUMENS
ightharpoonup	6	WP12	Single	0.921	COOPER - LUMARK	XTOR12B	20	WALL	612	12728

Calculation Summary									
Scenario: GEN									
Label	CalcType	Units	Avg	Max	Min	Avg/Min	Max/Min		
LIGHT TRESPASS	Illuminance	Fc	0.00	0.0	0.0	N.A.	N.A.		
PARKING LOT	Illuminance	Fc	2.26	9.9	0.3	7.53	33.00		

NOTES: - CALC AT GRADE

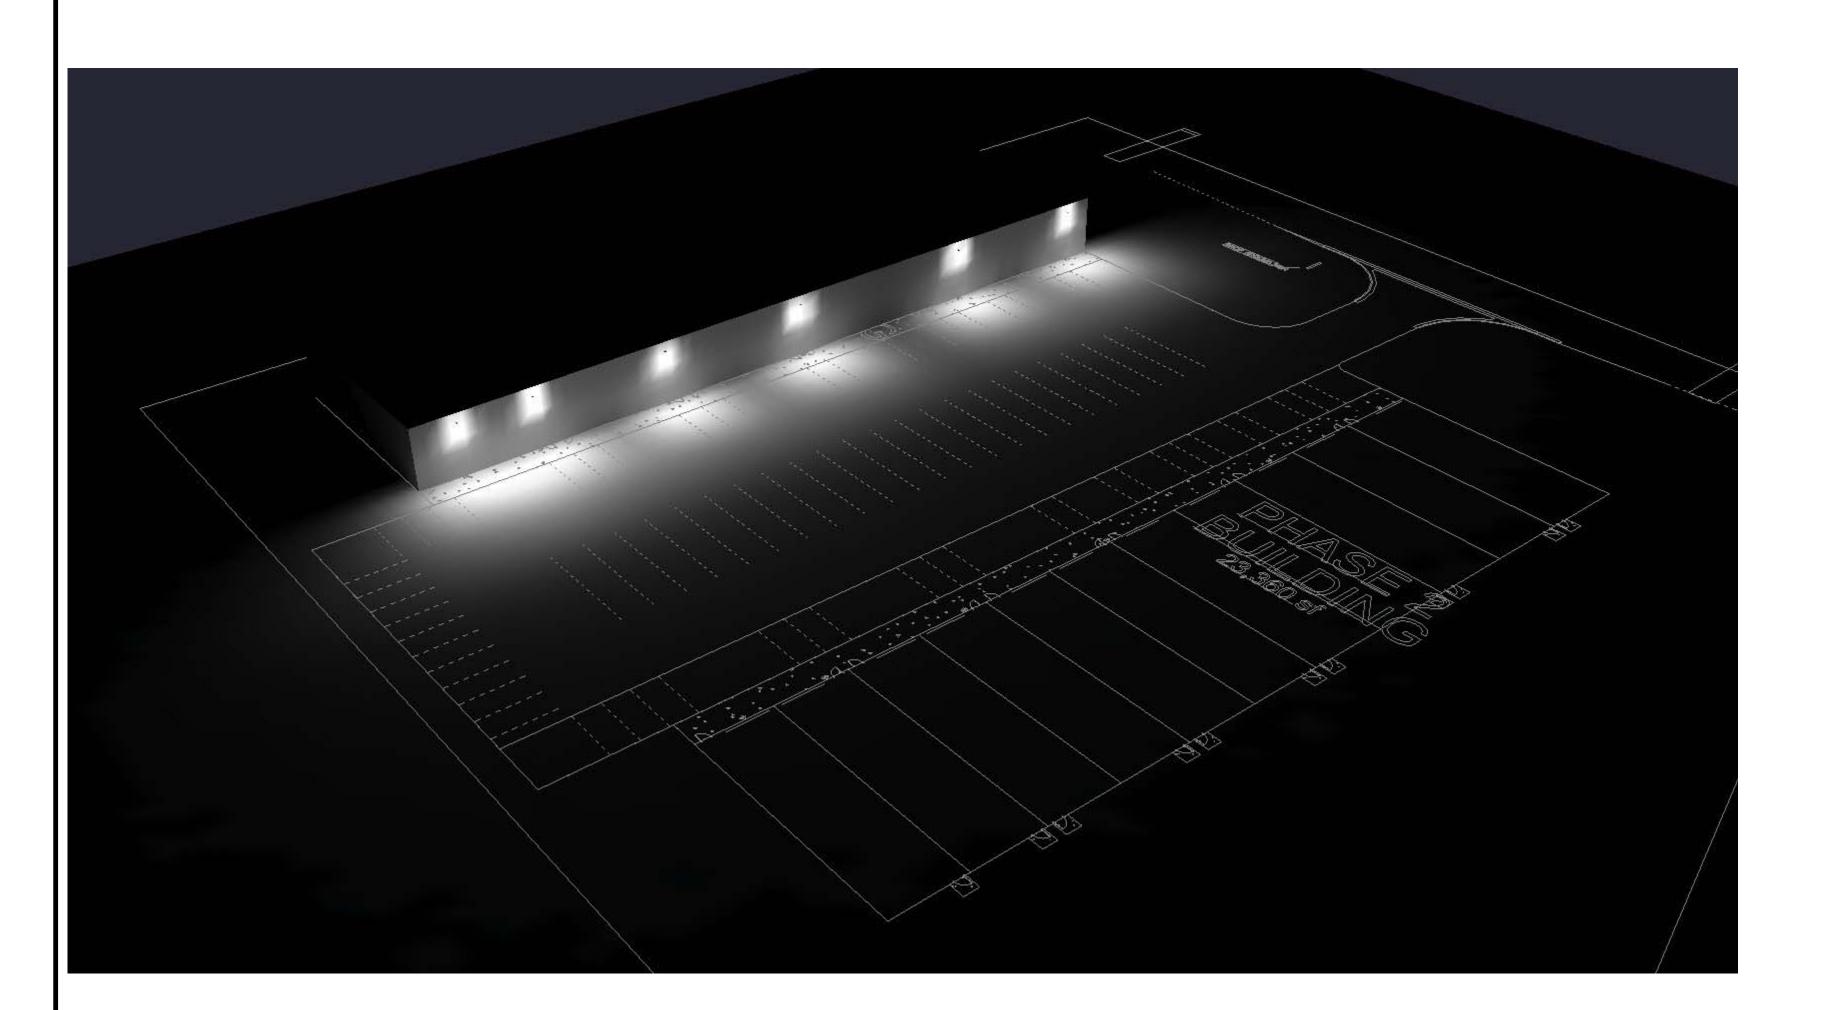

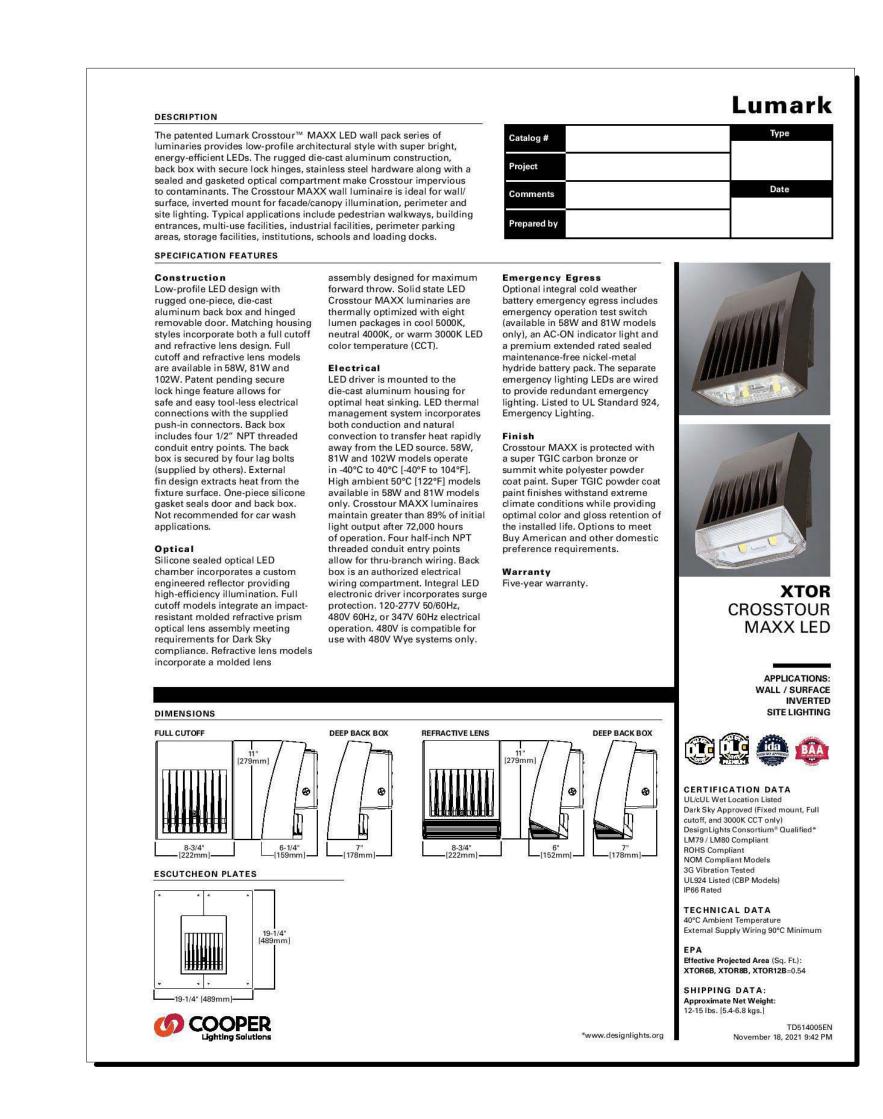



CTA LIGHTING & CONTROLS 908C West River Center Dr Comstock Park, MI 49321 616.647.2400

WWW.cta-lc.com

PHOTOMETRIC EVALUATION
NOT FOR CONSTRUCTION
Based on the information provided, all dimensions and luminain locations represent a recommended application. The engineer and/or architect must determine the applicability of the layout

regarding existing or future field conditions.

This lighting layout represents illumination levels calculated usin laboratory data taken under controlled conditions in accordance with The Illuminating Engineering Society (IES) approved metho Actual performance of a manufacturer's luminaires may vary due to changes in electrical voltage, tolerance in LEDs, and other field conditions. Calculations may not include obstructions such as buildings, curbs, landscaping, or other architectural elements. Fixture nomenclature may not include mounting hardware or poles. This layout is for photometric evaluation

purposes only and should not be used as a construction document or as a final document for ordering product.

DESIGNED FOR:



0 QUINCY S

SALES
QUOTES

2

DATE

9.8.2025 DESIGNER

REVISIONS

J YONKERS

DATE NAME

<u>SCHEDULES</u>

SCALE: NTS

2



CLIENT JDS LLC 12830 Quincy St Holland, MI 49424

PROJECT
New Building
PROJECT NO.

PROJE 5 New

**issue** 09.05.2025

drawn by ARM



CLIENT JDS LLC 12830 Quincy St Holland, MI 49424

PROJECT
New Building
PROJECT NO.

PROJE 5 New I

**issue** 09.05.2025

DRAWN BY ARM




CLIENT JDS LLC 12830 Quincy St Holland, MI 49424

PROJECT
New Building
PROJECT NO.
100

**issue** 09.05.2025

DRAWN BY ARM

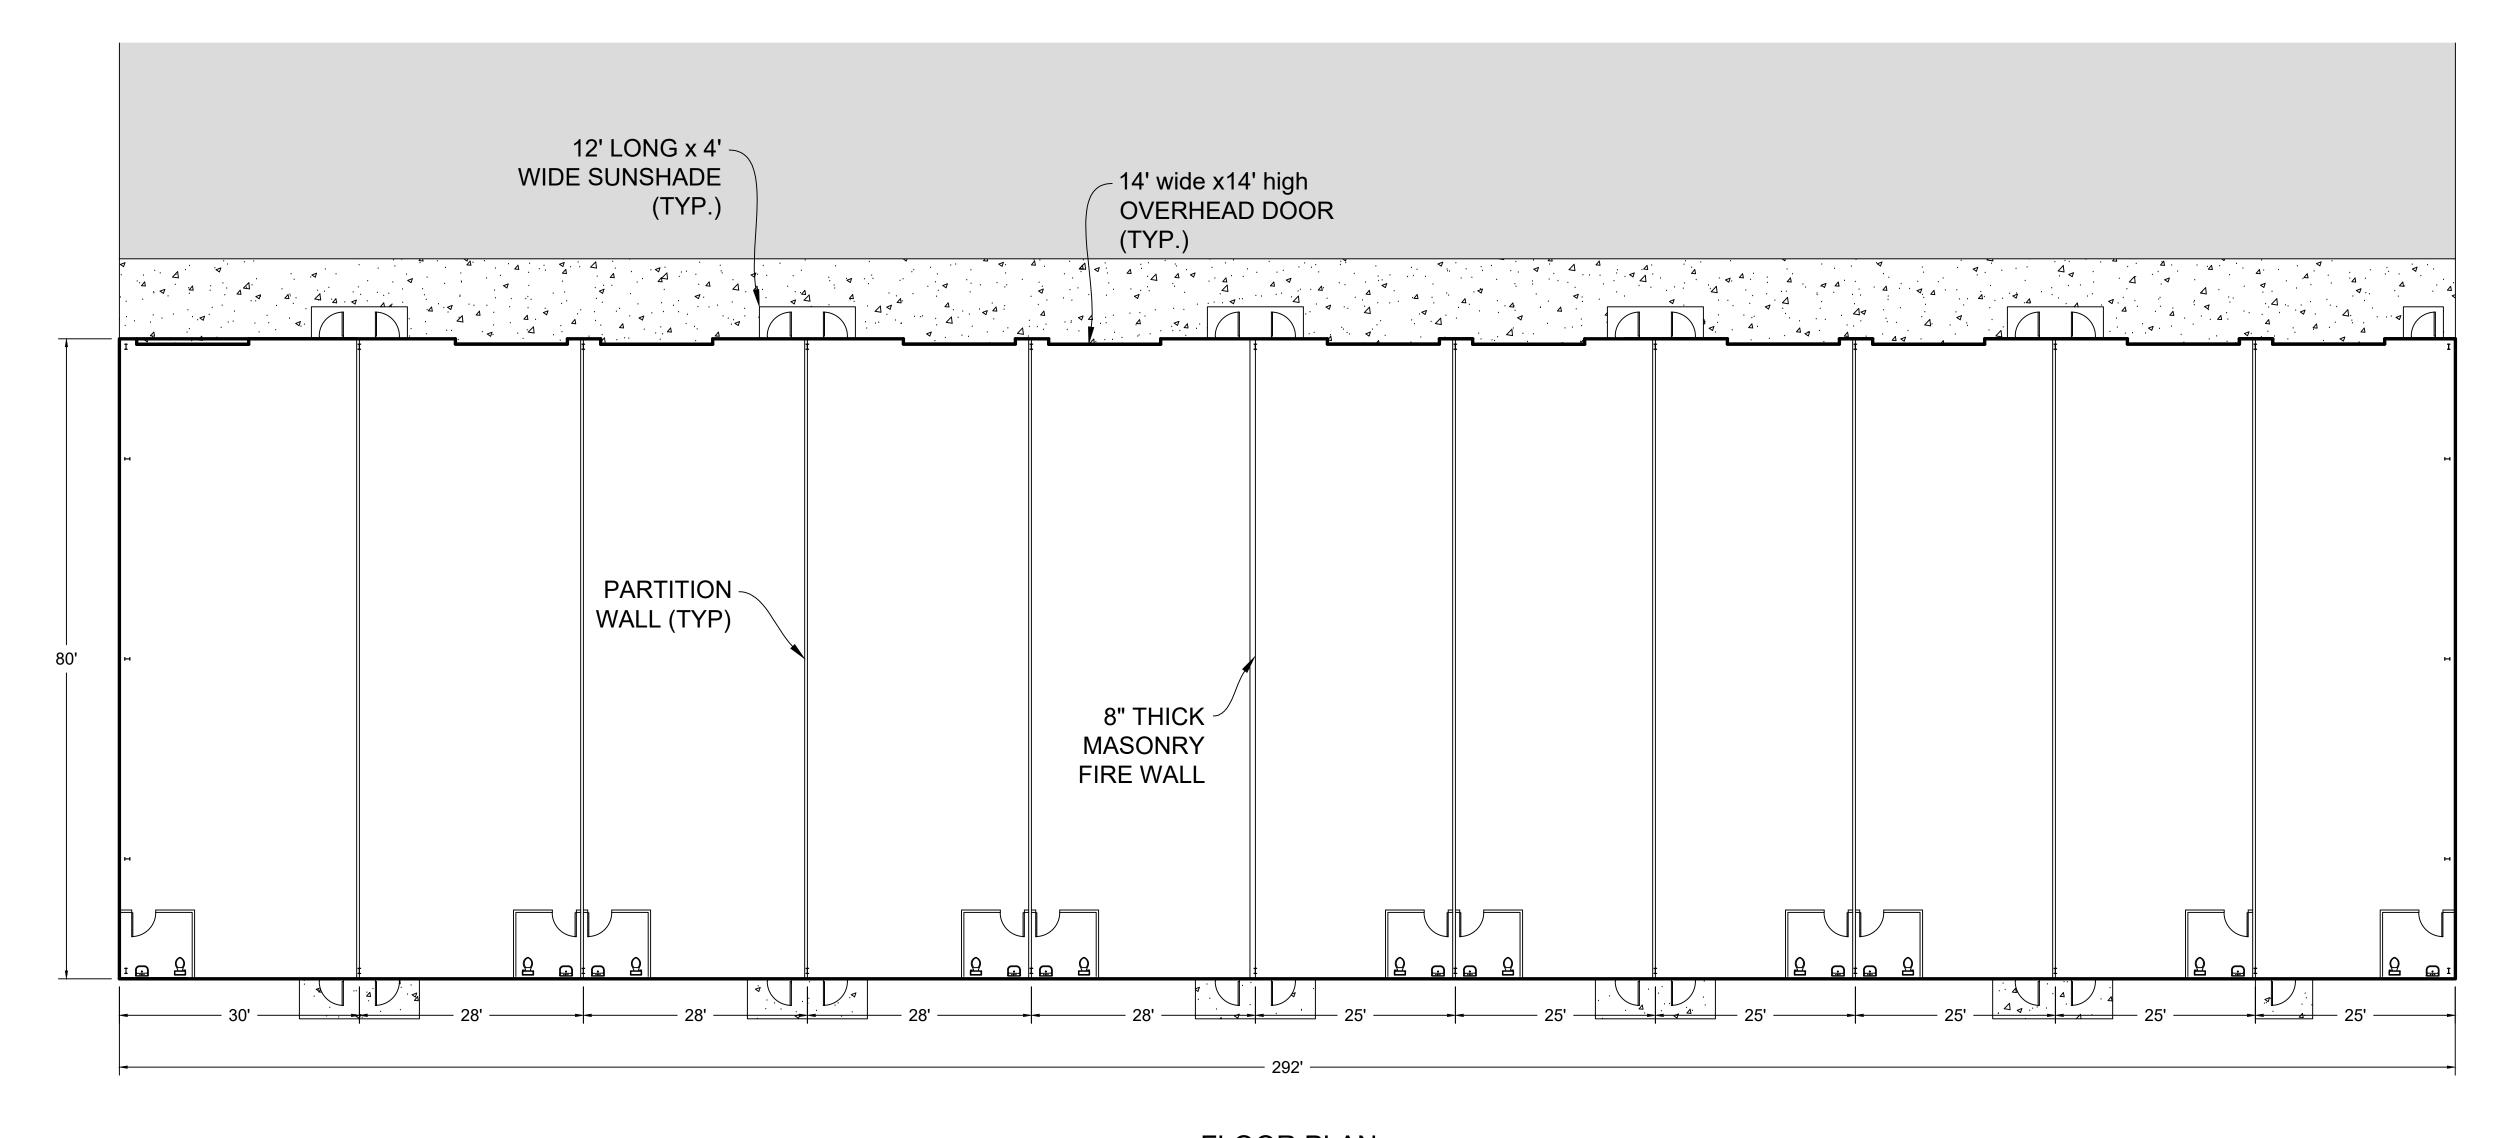

FLOOR PLAN
SCALE 3/32" =1'





DRAWN BY: ARM PROJECT NO.

> DATE: 9/05/2025

SHEET NO.

A1

OFFICE LAYOUT



CLIENT JDS LLC 12830 Quincy St Holland, MI 49424

PROJECT
New Building
PROJECT NO.

PROJE 5 New

**issue** 09.05.2025

drawn by ARM



CLIENT JDS LLC 12830 Quincy St Holland, MI 49424

PROJECT
New Building
PROJECT NO.

PROJE 5 New I

**issue** 09.05.2025

DRAWN BY ARM



CLIENT JDS LLC 12830 Quincy St Holland, MI 49424

PROJECT
New Building
PROJECT NO.
100

**issue** 09.05.2025

DRAWN BY ARM





